



DEPARTMENT OF PERMITTING, ENVIRONMENT, AND REGULATORY  
AFFAIRS (PERA)  
BOARD AND CODE ADMINISTRATION DIVISION  
**NOTICE OF ACCEPTANCE (NOA)**

MIAMI-DADE COUNTY  
PRODUCT CONTROL SECTION  
11805 SW 26 Street, Room 208  
Miami, Florida 33175-2474  
T (786) 315-2590 F (786) 315-2599  
[www.miamidade.gov/pera/](http://www.miamidade.gov/pera/)

**Peeetz Windows and Doors, Inc.**  
**15951 S.W. 41 Street, Suite 150**  
**Weston, FL 33331**

**SCOPE:**

This NOA is being issued under the applicable rules and regulations governing the use of construction materials. The documentation submitted has been reviewed and accepted by Miami-Dade County PERA -Product Control Section to be used in Miami Dade County and other areas where allowed by the Authority Having Jurisdiction (AHJ).

This NOA shall not be valid after the expiration date stated below. The Miami-Dade County Product Control Section (In Miami Dade County) and/or the AHJ (in areas other than Miami Dade County) reserve the right to have this product or material tested for quality assurance purposes. If this product or material fails to perform in the accepted manner, the manufacturer will incur the expense of such testing and the AHJ may immediately revoke, modify, or suspend the use of such product or material within their jurisdiction. PERA reserves the right to revoke this acceptance, if it is determined by Miami-Dade County Product Control Section that this product or material fails to meet the requirements of the applicable building code.

This product is approved as described herein, and has been designed to comply with the Florida Building Code, including the High Velocity Hurricane Zone.

**DESCRIPTION: Series “European” Outswing Glazed Wood Doors – L.M.I.**

**APPROVAL DOCUMENT:** Drawing No. 1440, titled “European Outswing Impact Wood Door”, sheets 1 through 9 of 9, dated June 09, 2010, prepared by W. W. Schafer Engineering & Consulting, P. A., signed and sealed by Warren W. Schafer, P. E., bearing the Miami-Dade County Product Control Revision stamp with the Notice of Acceptance number and Expiration date by the Miami-Dade County Product Control Section.

**MISSILE IMPACT RATING: Large and Small Missile Impact Resistant**

**Limitation:**

1. Hinges to be located 8” from top or bottom of frame and not to exceed =27” O.C.

**LABELING:** Each unit shall bear a permanent label with the manufacturer's name or logo, Kall/Eifel, Germany and series and following statement: "Miami-Dade County Product Control Approved", unless otherwise noted herein.

**RENEWAL** of this NOA shall be considered after a renewal application has been filed and there has been no change in the applicable building code negatively affecting the performance of this product.

**TERMINATION** of this NOA will occur after the expiration date or if there has been a revision or change in the materials, use, and/or manufacture of the product or process. Misuse of this NOA as an endorsement of any product, for sales, advertising or any other purposes shall automatically terminate this NOA. Failure to comply with any section of this NOA shall be cause for termination and removal of NOA.

**ADVERTISEMENT:** The NOA number preceded by the words Miami-Dade County, Florida, and followed by the expiration date may be displayed in advertising literature. If any portion of the NOA is displayed, then it shall be done in its entirety.

**INSPECTION:** A copy of this entire NOA shall be provided to the user by the manufacturer or its distributors and shall be available for inspection at the job site at the request of the Building Official.

This NOA revises NOA # 10-0615.06 and consists of this page 1 and evidence pages E-1, as well as approval document mentioned above.

The submitted documentation was reviewed by **Ishaq I. Chanda, P.E.**



NOA No 11-1024.17  
Expiration Date: December 22, 2015  
Approval Date: December 08, 2011  
Page 1

11/30/11

**NOTICE OF ACCEPTANCE: EVIDENCE SUBMITTED**

**A. DRAWINGS (transferred from file # 10-0615.06)**

1. Manufacturer's die drawings and sections.
2. Drawing No. 1440, titled "European Outswing Impact Wood Door", sheets 1 through 9 of 9, dated June 09, 2010, prepared by W. W. Schafer Engineering & Consulting, P. A., signed and sealed by Warren W. Schafer, P.E.

(Note: The revision consist of compliance to FBC 2010 only)

**B. TESTS (transferred from file # 10-0615.06)**

1. Test reports on:
  - 1) Air Infiltration Test, per FBC, TAS 202-94
  - 2) Uniform Static Air Pressure Test, Loading per FBC TAS 202-94
  - 3) Water Resistance Test, per FBC, TAS 202-94
  - 4) Large Missile Impact Test per FBC, TAS 201-94
  - 5) Cyclic Wind Pressure Loading per FBC, TAS 203-94
  - 6) Forced Entry Test, per FBC 2411 3.2.1, TAS 202-94

along with the manufacturer's parts drawings, installation diagram and marked-up drawings of a outswing wood door prepared by Hurricane Test Laboratory, Inc. Test Report No. HTL-0284-0527-03, dated 05/22-28/03, signed and sealed by Vinu J. Abraham, P.E.

**C. CALCULATIONS**

1. Statement letters of conformance to FBC 2010, dated OCT 19, 2011, prepared by W. W. Schafer Engineering & Consulting, P. A., signed and sealed by Warren W. Schafer, P.E.
2. Anchor verification calculations complying w/ FBC-2007, dated 06-09-10, prepared, signed and sealed by Warren W. Schafer, P.E. (transferred from file # 10-0615.06)
3. Glazing complies with ASTM E-1300-02 &-04

**D. QUALITY ASSURANCE**

1. Miami Dade Department of Permitting, Environment, and Regulatory Affairs (PERA).

**E. MATERIAL CERTIFICATIONS**


1. Notice of Acceptance No. 08-1224.04 issued to Solutia, for "Saflex Composite Glass Interlayer w/ PET", expiring on 12/11/2013.
2. Notice of Acceptance No. 11-0325.05 issued to Solutia Inc. for "Saflex Clear or colored interlayer", expiring on May 21, 2016.

**F. STATEMENTS**

1. Statement letters of conformance to FBC 2010, dated OCT 19, 2011, prepared by W. W. Schafer Engineering & Consulting, P. A., signed and sealed by Warren W. Schafer, P.E.
2. Statement letters of conformance to FBC 2007 and "No financial interest", both dated June 09, 2010, prepared by W. W. Schafer Engineering & Consulting, P. A., signed and sealed by Warren W. Schafer, P.E. (transferred from file # 10-0615.06)
3. Statement of compliance, issued as part of the above referenced test reports.
4. Distributor Agreement dated August 18, 2010, between Helmut Peetz, GMBH and Peetz Windows and Doors, Inc., signed respectively by Christian Peetz, President of Helmut Peetz, GmbH, and by Eva Leon, V. P. of Peetz Windows and Doors, Inc.

**G. OTHER**

1. This NOA revises NOA # 10-0615.06, expiring on 12/22/15.
2. Test Proposals # 03-0230, approved by BCCO.

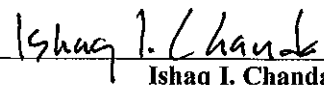

Ishaq I. Chanda, P.E.  
Product Control Examiner  
NOA No 11-1024.17

Expiration Date: December 22, 2015  
Approval Date: December 08, 2011

# GENERAL NOTES:

1. THESE DOOR SYSTEMS HAVE BEEN TESTED, ANALYZED & APPROVED FOR DESIGN PRESSURES NOT TO EXCEED THOSE SHOWN IN THE "ALLOWABLE DESIGN PRESSURE TABLE(S)".
2. OPENINGS, BUCKING & BUCKING FASTENERS MUST BE PROPERLY DESIGNED & INSTALLED TO TRANSFER WIND LOADS TO THE STRUCTURE.
3. ALL HARDWARE & FASTENERS SHALL BE IN ACCORDANCE WITH THESE DRAWINGS & SHALL NOT VARY UNLESS SPECIFICALLY MENTIONED ON THE DRAWINGS. SPECIFIED ANCHOR EMBED TO BASE MATERIAL SHALL BE BEYOND WALL FINISH OR STUCCO.
4. THE DETAILS & SPECIFICATIONS SHOWN HEREIN REPRESENT THE PRODUCTS TESTED & PROPOSED FOR WATER, AIR, IMPACT, CYCLIC & UNIFORM STATIC AIR PRESSURE TESTING IN CONFORMANCE WITH THE FLORIDA BUILDING CODE PROTOCOLS TAS-201, 202 & 203 FOR LARGE MISSILE IMPACT DOORS.
5. THESE DOOR SYSTEMS HAVE BEEN DESIGNED IN ACCORDANCE WITH AND MEET THE REQUIREMENTS OF THE FLORIDA BUILDING CODE (FBC) INCLUDING HIGH VELOCITY HURRICANE ZONES (HVHZ).
6. IMPACT SHUTTERS ARE NOT REQUIRED WITH THESE DOORS.
7. ALL ANCHORS SECURING DOOR FRAME TO PRESSURE TREATED BUCKS OR WOOD FRAMING SHALL BE CAPABLE OF RESISTING CORROSION CAUSED BY THE PRESSURE TREATING CHEMICALS IN THE WOOD.
8. DETERMINE THE POSITIVE & NEGATIVE DESIGN LOADS TO USE WHEN REFERENCING THESE DOCUMENTS IN ACCORDANCE WITH THE GOVERNING CODE AND GOVERNING WIND VELOCITY. FOR WIND LOAD CALCULATIONS IN ACCORDANCE WITH THE FLORIDA BUILDING CODE, A DIRECTIONALITY FACTOR OF  $K_d = 0.85$  MAY BE APPLIED PER THE ASCE-7 STANDARD.
9. NO INCREASE IN ALLOWABLE STRESS HAS BEEN USED IN THE CERTIFICATION OF THIS PRODUCT. WIND LOAD DURATION FACTOR  $C_d = 1.6$  WAS USED FOR WOOD SCREW ANALYSIS ONLY.
10. MATERIALS, INCLUDING BUT NOT LIMITED TO STEEL SCREWS, THAT COME INTO CONTACT WITH OTHER DISSIMILAR MATERIALS SHALL MEET THE REQUIREMENTS OF FLORIDA BUILDING CODE CHAPTER 20.
11. ALL WOOD MEMBERS OF DOORS THAT MAY POSSIBLY COME INTO CONTACT WITH MASONRY OR CONCRETE SUBSTRATES, ARE SUBJECT TO MOISTURE &/OR ARE SUBJECT TO THE OUTSIDE ENVIRONMENT SHALL BE OF AN APPROVED DURABLE SPECIES OR BE TREATED IN AN APPROVED METHOD WITH AN APPROVED PRESERVATIVE PER FBC SECTION 2326.


## CORNER & MULLION END CONSTRUCTION:

JAMB TO JAMB: HORIZONTAL MEMBER IS COPE, BUTTED TO VERTICAL MEMBER, JOINED WITH FOUR(4) 0.236" X 4.724" LONG GALVANIZED WOOD SCREWS & GLUED WITH BINDAH D4 OR EQUIVALENT WOOD GLUE.  
JAMB TO SILL: VERTICAL MEMBER IS BUTTED TO SILL & JOINED WITH FOUR(4) 0.236" X 4.724" LONG S.S. WOOD SCREWS.  
MID-RAIL TO STILE: MID-RAIL IS COPE, BUTTED TO JAMB & JOINED WITH FOUR(4) 0.394" X 3.15" LONG WOOD DOWELS AND GLUED WITH BINDAH D4 OR EQUIVALENT WOOD GLUE.  
MULLIONS TO JAMB: MULLION IS COPE, BUTTED TO JAMB & JOINED WITH SIX(6) 0.394" X 3.15" LONG WOOD DOWELS AND GLUED WITH BINDAH D4 OR EQUIVALENT WOOD GLUE.  
MULLION TO SILL: MULLION IS BUTTED TO SILL & JOINED WITH FOUR(4) 0.236" X 4.724" LONG GALVANIZED WOOD SCREWS.  
SASH: COPE, BUTTED TOGETHER, JOINED WITH SIX (6) 3/8" X 3 1/8" WOOD DOWELS & GLUED WITH BINDAH D4 OR EQUIVALENT WOOD GLUE.

## FRAME ANCHOR REQUIREMENTS TABLE

OPENING TYPE (SUBSTRATE)	FRAME/BACKET TO OPENING FASTENER TYPE	MINIMUM EMBED	MINIMUM EDGE DIST.
HEAD & SIDE FRAME SCREWS			
MIN. 2X4 WOOD FRAME OR BUCK (MIN. GR. 3 & G=0.55)	NO. 18 (0.295 DIA.) SMS OR WOOD SCREW	1 3/8"	3/4"
MIN. 1/8" THK 6063-T5 ALUM.	5/16" GR. 5 SELF TAP/DRILL SCREW	FULL	1/2"
MIN. 1/8" THK A36 STEEL	5/16" GR. 5 SELF TAP/DRILL SCREW	FULL	1/2"
MIN. C-90 CMU OR 2500 PSI CONCRETE	(1) 5/16" CONCRETE SCREW	1 1/2"	2 1/2"
SILL SCREWS			
MIN. 2X4 WOOD FRAME OR BUCK (MIN. GR. 3 & G=0.55)	NO. 14 SMS OR WOOD SCREW	1 3/8"	1/2"
MIN. 2500 PSI CONCRETE	(2) 1/4" CONCRETE SCREW	1 1/2"	2 1/2"
MOUNTING BRACKET SCREWS			
MIN. 2X6 WOOD FRAME OR BUCK (MIN. GR. 3 & G=0.55)	NO. 8 SMS OR WOOD SCREW	1 3/8"	1/2"
MIN. 1/8" THK 6063-T5 ALUMINUM	NO. 8 GR. 5 SELF TAP/DRILL SCREW	FULL	1/2"
MIN. 1/8" THK A36 STEEL	NO. 8 GR. 5 SELF TAP/DRILL SCREW	FULL	1/2"

- (1) HEAD & SIDE CONCRETE SCREWS SHALL BE 5/16" ELCO ULTRACONS (HARDENED STEEL OR S.S.).  
(2) SILL CONCRETE SCREWS SHALL BE 1/4" ELCO ULTRACONS, ELCO CRETE-FLEX, ITW RAMSET/RED HEAD TAPCONS OR HILTI KWIK-CON II (HARDENED STEEL OR S.S.).

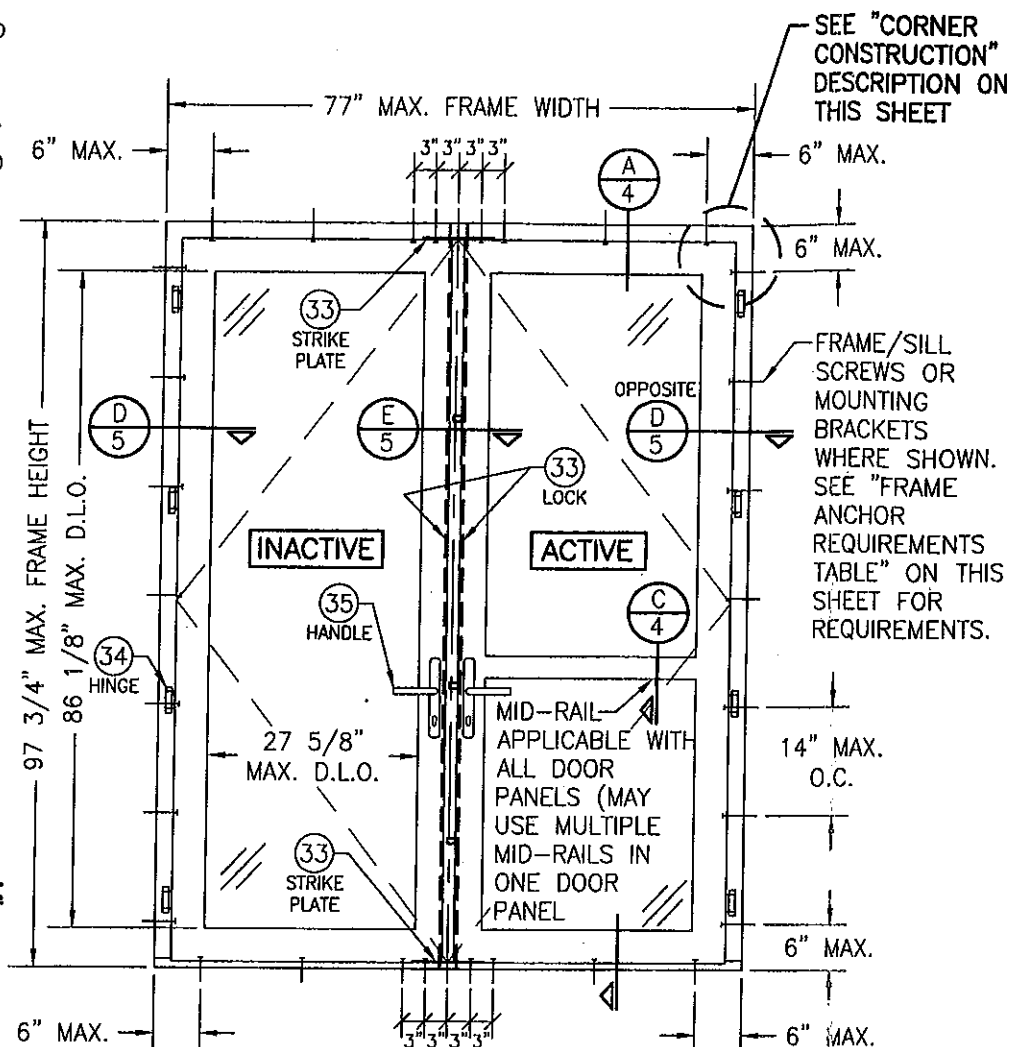

EXTERIOR ELEVATION  
DOUBLE RECTANGULAR OUTSWING DOOR


SCALE: 1/2" = 1'-0"

## ALLOWABLE DESIGN PRESSURE (ALL DOORS)

+60/-70 PSF

## HINGE REQUIREMENTS

FRAME HEIGHT	QUANTITY PER PANEL
ALL HEIGHTS	4

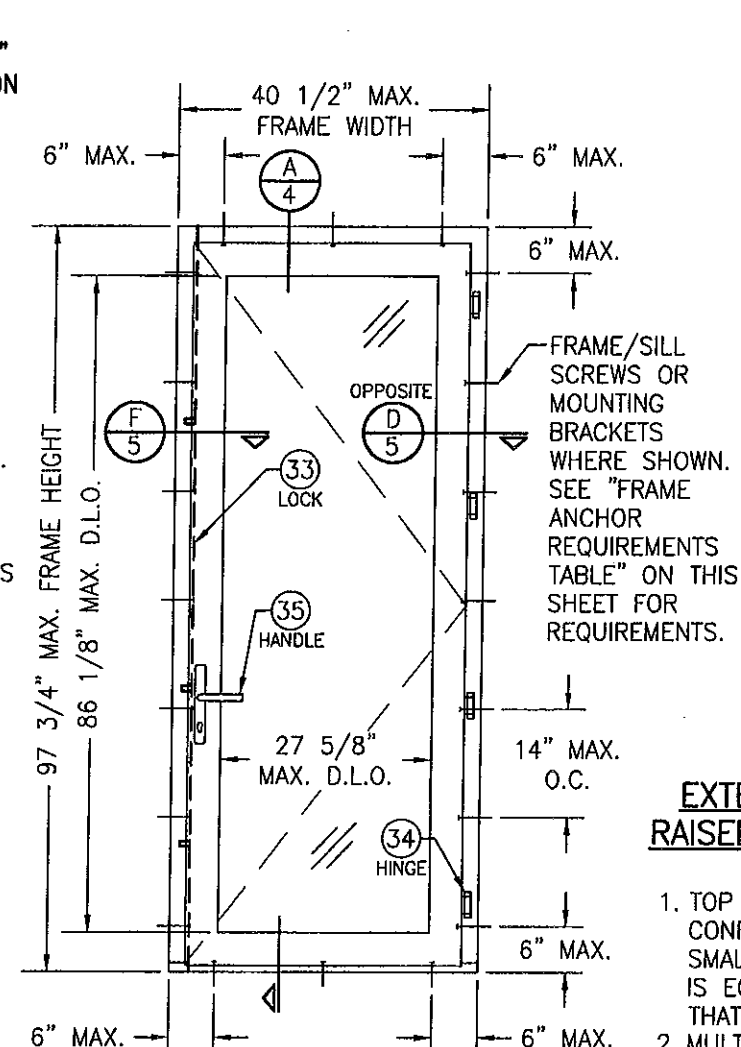

EXTERIOR ELEVATION  
SINGLE RECTANGULAR OUTSWING DOOR


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PRODUCT RENEWED  
as complying with the Florida  
Building Code  
Acceptance No. 10-0615-06  
Expiration Date DEC 27, 2015

By Ishag I. Chaudhry  
Miami-Dade Product Control  
Division

PRODUCT REVISED  
as complying with the Florida  
Building Code  
Acceptance No. 11-1024.17  
Expiration Date 12/22/15


Ishag I. Chaudhry  
Miami-Dade Product Control  
Division

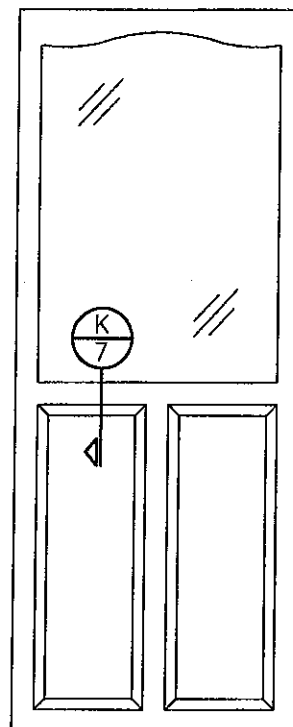

EXTERIOR ELEVATION SOLID  
RAISED PANEL WITH MID RAILS

SCALE: 1/2" = 1'-0"




1. TOP & MID RAILS MAY BE OF ANY CONFIGURATION PROVIDING THE SMALLEST CROSS SECTION OF RAILS IS EQUAL TO OR LARGER THAN THAT DETAILED IN DRAWINGS.
2. MULTIPLE MID RAIL (BOTH HORIZONTAL & VERTICAL) MAY BE USED WITH THESE PANELS.
3. PARTIAL PANEL CONDITION IS SHOWN ABOVE. FULL PANEL DOORS AND OTHER PANEL CONFIGURATIONS ARE ALSO PART OF THIS APPROVAL AND ARE SIMILAR IN CONSTRUCTION TO THAT SHOWN ABOVE.
4. PANEL ONLY IS SHOWN. FOR INSTALLATION INTO FRAME, SEE OTHER ELEVATIONS.

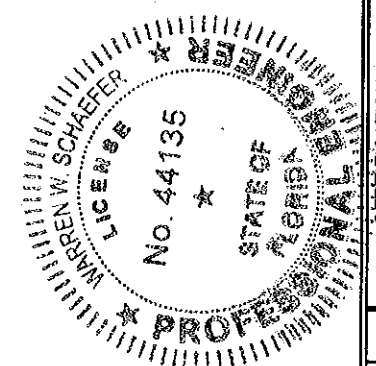

DRAWN BY: C.A.G.	CHECKED BY: W.W.S.
PLOT: 1=24	DATE: 8/31/05
DATE 05/04/10	BY WRM
REVISION DESCRIPTION	NO.
1 UPDATE TO PRESENT STANDARDS	A1
EUROPEAN OUTSWING IMPACT WOOD DOORS	
CONSULTANTS W. W. SCHAEFER ENGINEERING & CONSULTING, P.A. 7480 150TH COURT NORTH PALM BEACH GARDENS, FL 33418 PHONE: 561-744-3424	
MANUFACTURER PEETZ WINDOWS & DOORS 15951 S.W. 41ST STREET, SUITE 150 WESTON, FL 33331 954-659-3887	
CERTIFICATION JUN 09 2010	DRAWING NO. 1440
REV. A	SHEET NO. 1 OF 9







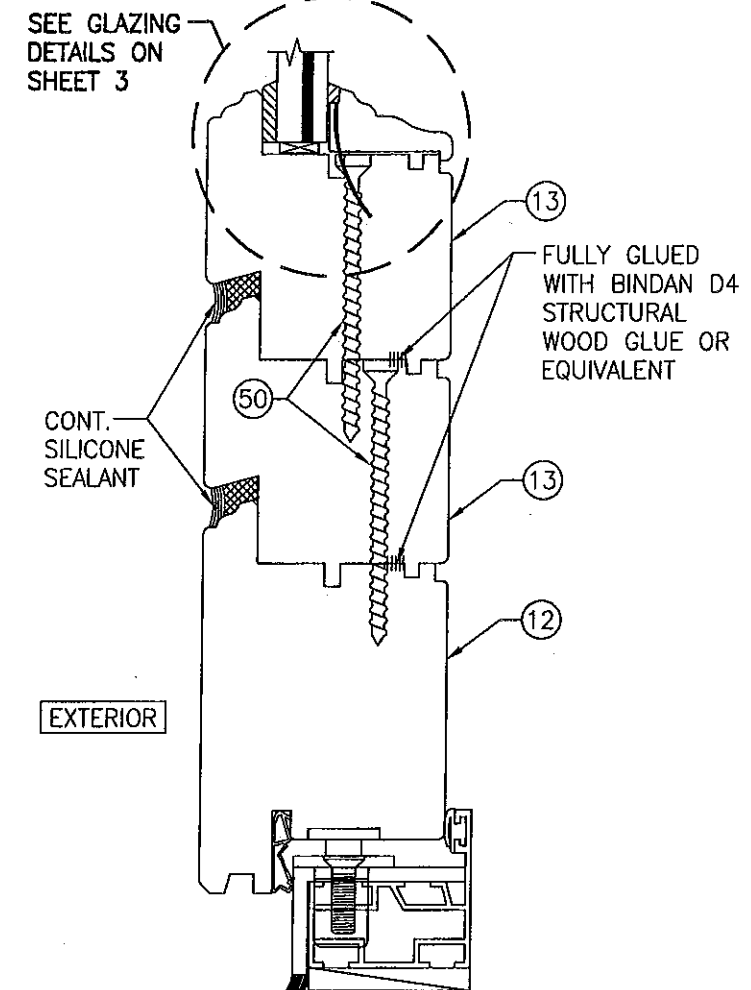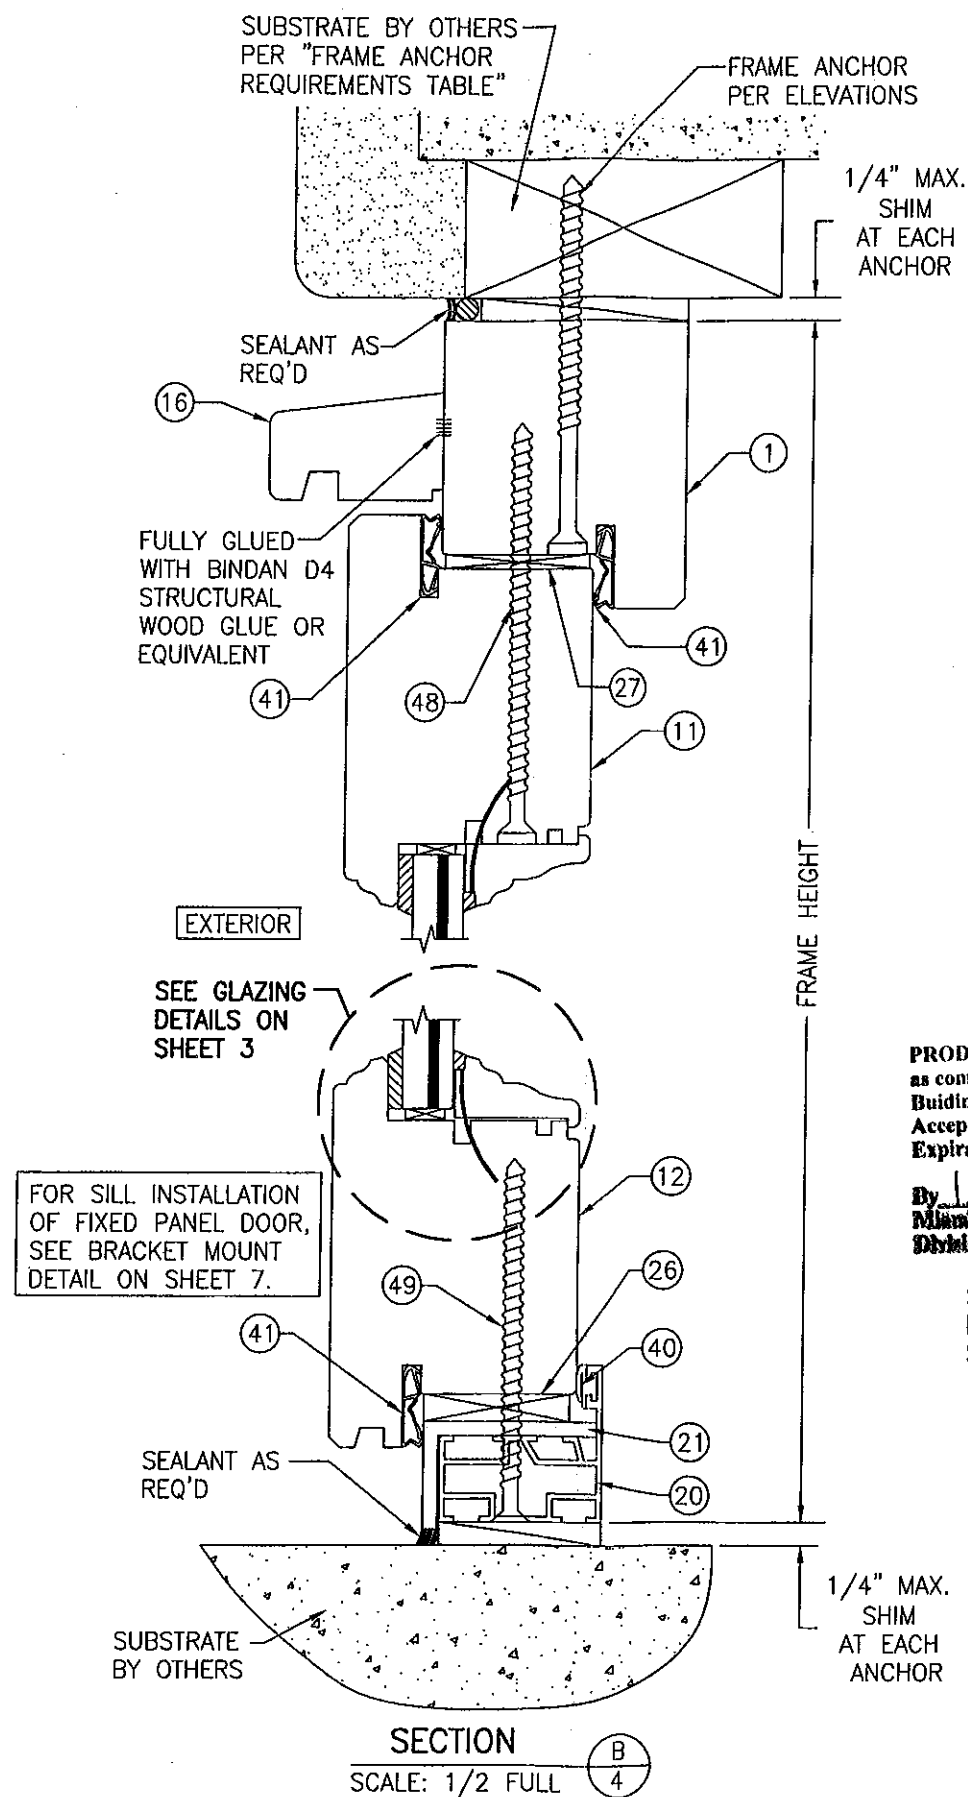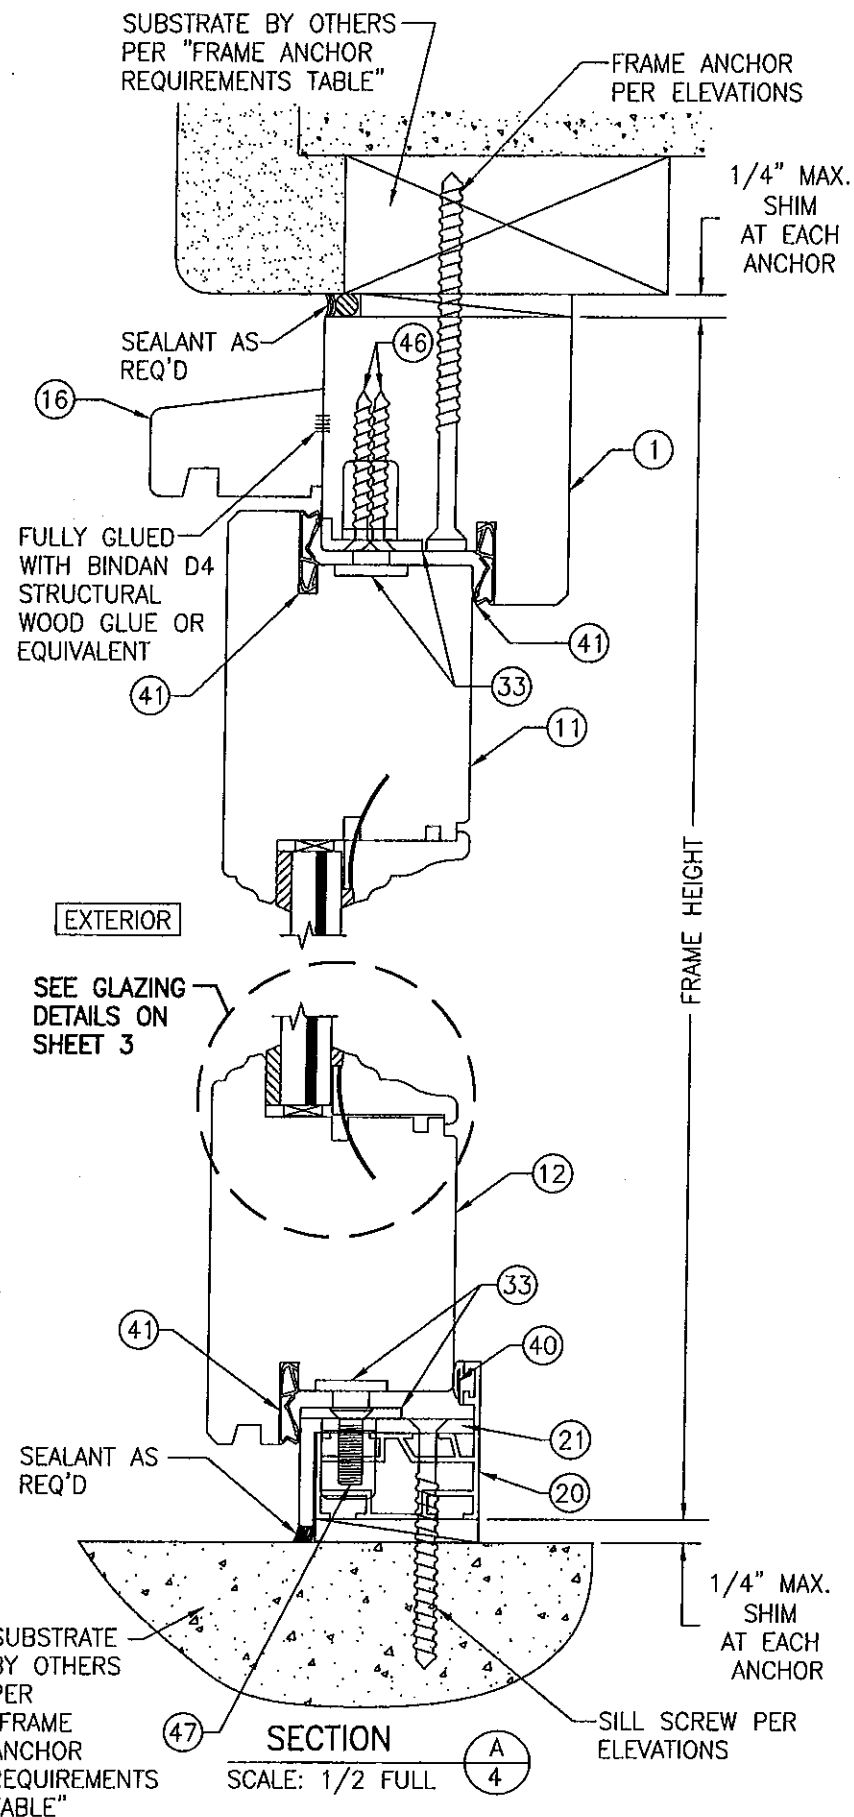





### ALTERNATE BOTTOM RAIL CONDITION (SEE SECTIONS A/4 AND B/4 FOR INSTALLATION DETAIL)

PRODUCT RENEWED  
as complying with the Florida  
Building Code  
Acceptance No. 10-0615-06  
Expiration Date DEC 22, 2015  
By Ishag L. Chaudhry  
Miami Code Product Control  
Director

PRODUCT REVISED  
as complying with the Florida  
Building Code  
Acceptance No. 11-1024-17  
Expiration Date 12/22/15  
By Ishag L. Chaudhry  
Miami Code Product Control  
Director

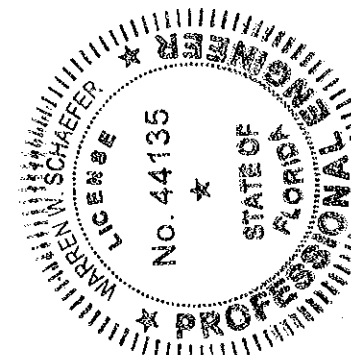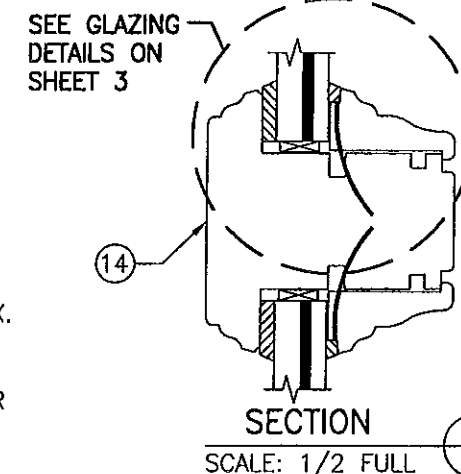


DRAWN BY: W.R.M.	CHECKED BY: W.W.S.
PLOT: 1-24	DATE: 9/8/05
DATE	BY
REVISION DESCRIPTION	NO.
EUROPEAN OUTSWING IMPACT WOOD DOORS	
MANUFACTURER	
PEETZ WINDOWS & DOORS	
15951 S.W. 41ST STREET, SUITE 150	
WESTON, FL 33331	
954-659-3887	
CONSULTANTS	
W. W. SCHAEFER ENGINEERING & CONSULTING, P.A.	
7480 150TH COURT NORTH	
PALM BEACH GARDENS, FL 33418	
PHONE: 561-744-3424	
CERTIFICATION	JUN 09 2010
DRAWING NO.	REV.
1440	A
SHEET NO.	4 OF 9

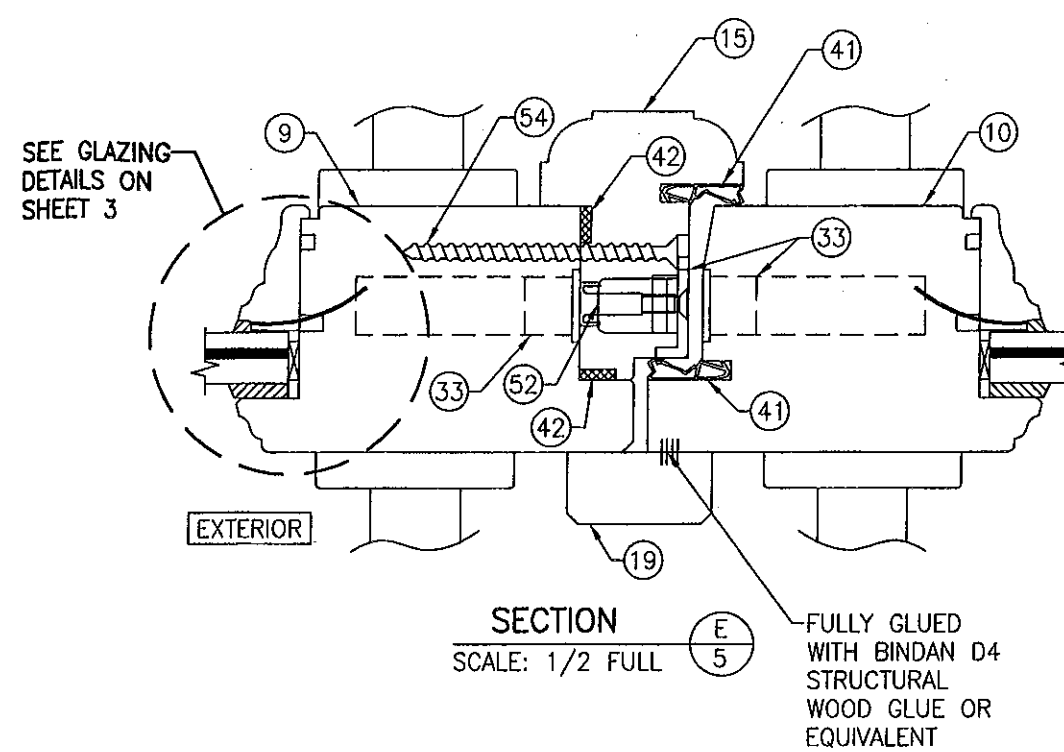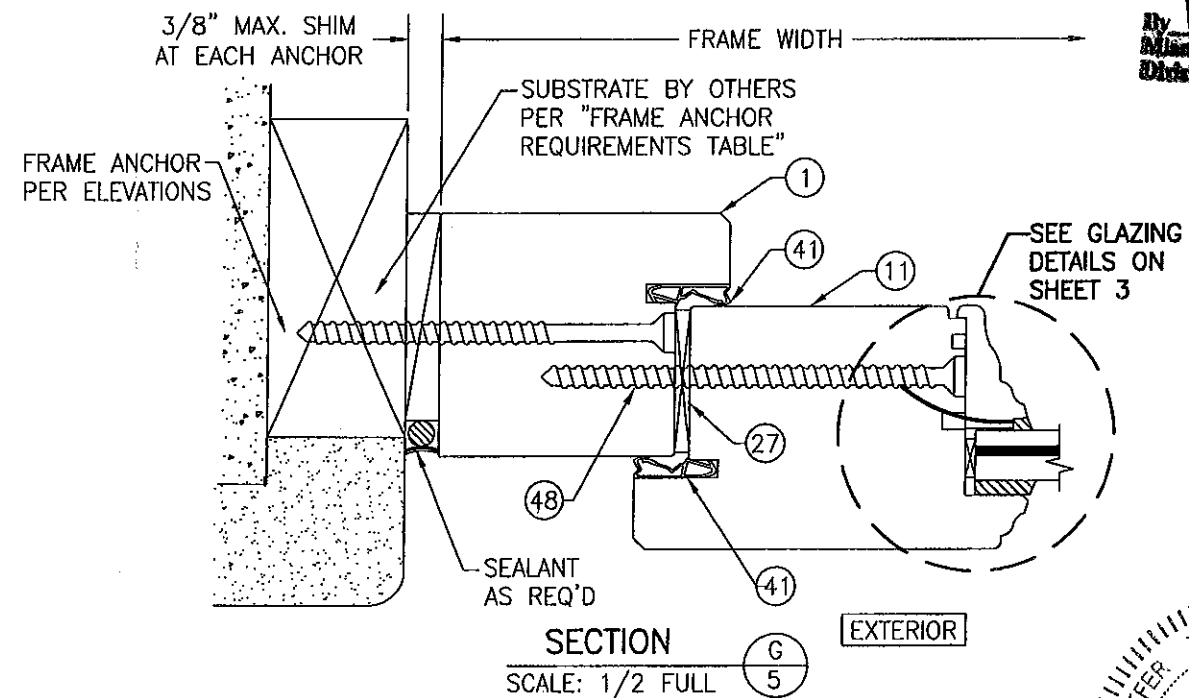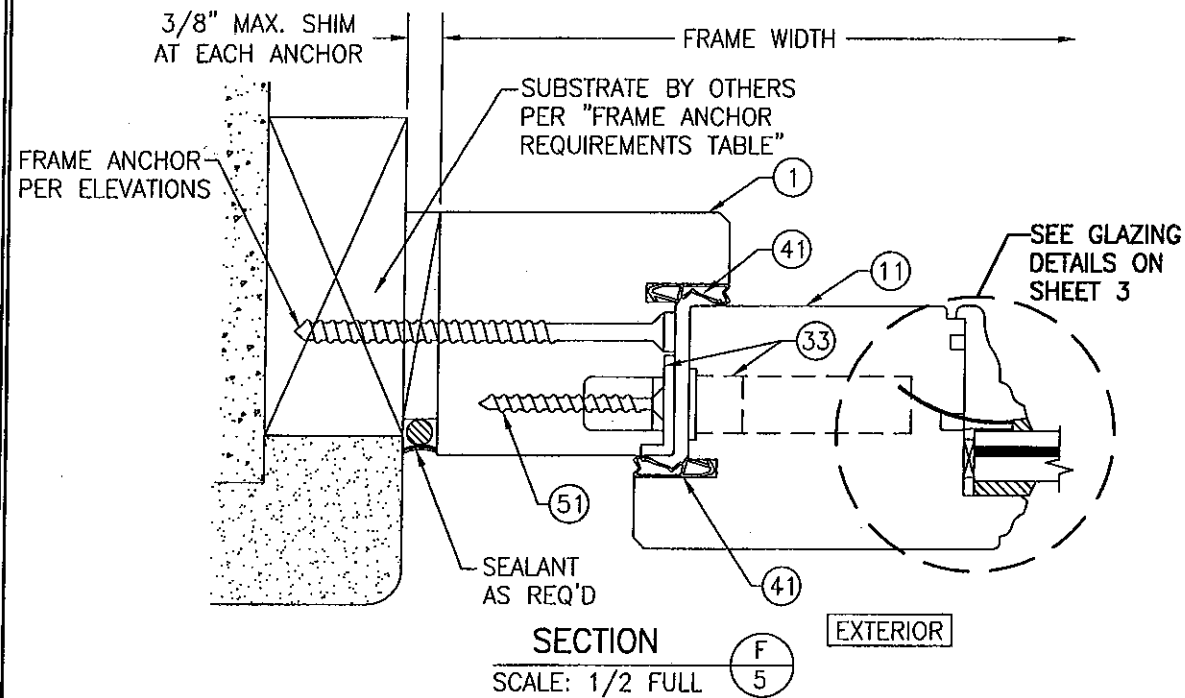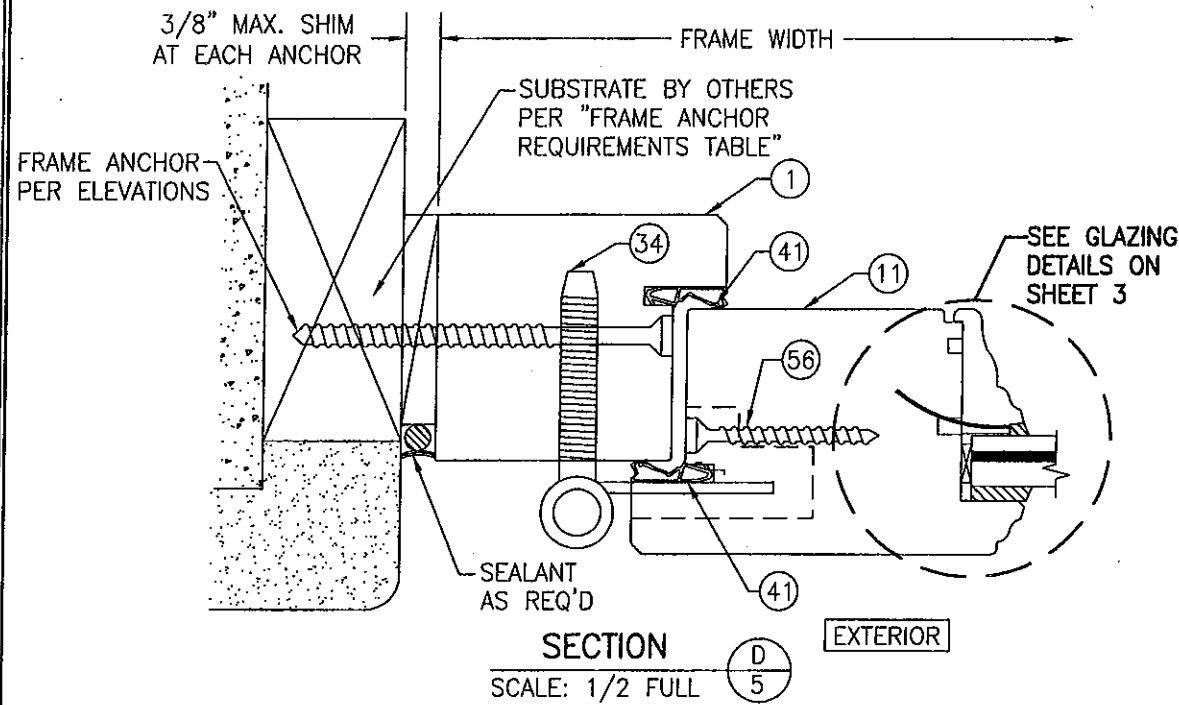


**PRODUCT REVISED**  
 as complying with the Florida  
 Building Code  
 Acceptance No. 11-1024-17  
 Expiration Date 12/22/16  
 By *Isaac L. Chant*  
 Miami Trade Product Control  
 Director

**PRODUCT RENEWED**  
 as complying with the Florida  
 Building Code  
 Acceptance No. 10-0615-08  
 Expiration Date DEC 22, 2015  
 By *Isaac L. Chant*  
 Miami Trade Product Control  
 Director

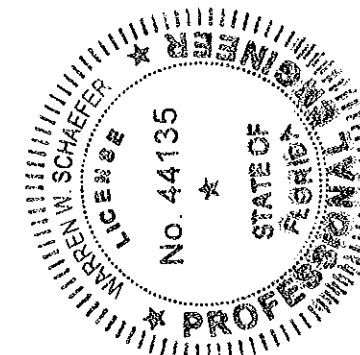


DRAWN BY: W.R.M.		CHECKED BY: W.W.S.	
PLOT: 1=24		DATE: 9/8/05	
NO.	REVISION	DESCRIPTION	DATE
DRAWING TITLE: EUROPEAN OUTSWING IMPACT WOOD DOORS			
CONSULTANTS W. W. SCHAEFER ENGINEERING & CONSULTING, P.A. 7480 150TH COURT NORTH PALM BEACH GARDENS, FL 33418 PHONE: 561-744-3424		MANUFACTURER PEETZ WINDOWS & DOORS 15951 S.W. 41ST STREET, SUITE 150 WESTON, FL 33331 954-659-3887	
CERTIFICATION JUN 09 2010 WARREN W. SCHAEFER, P.E. P.E. NO. 44135		DRAWING NO. 1440 SHEET NO. 5 OF 9	




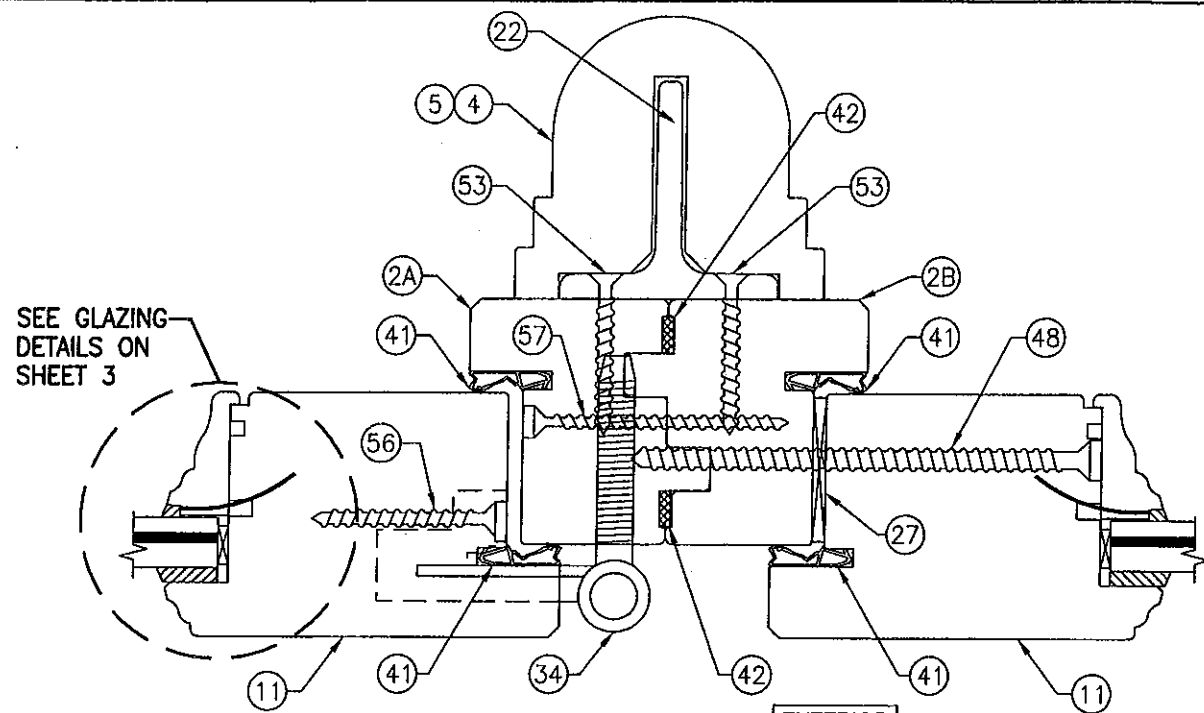


SECTION H1  
SCALE: 1/2 FULL  
(2 PIECE MULLION)

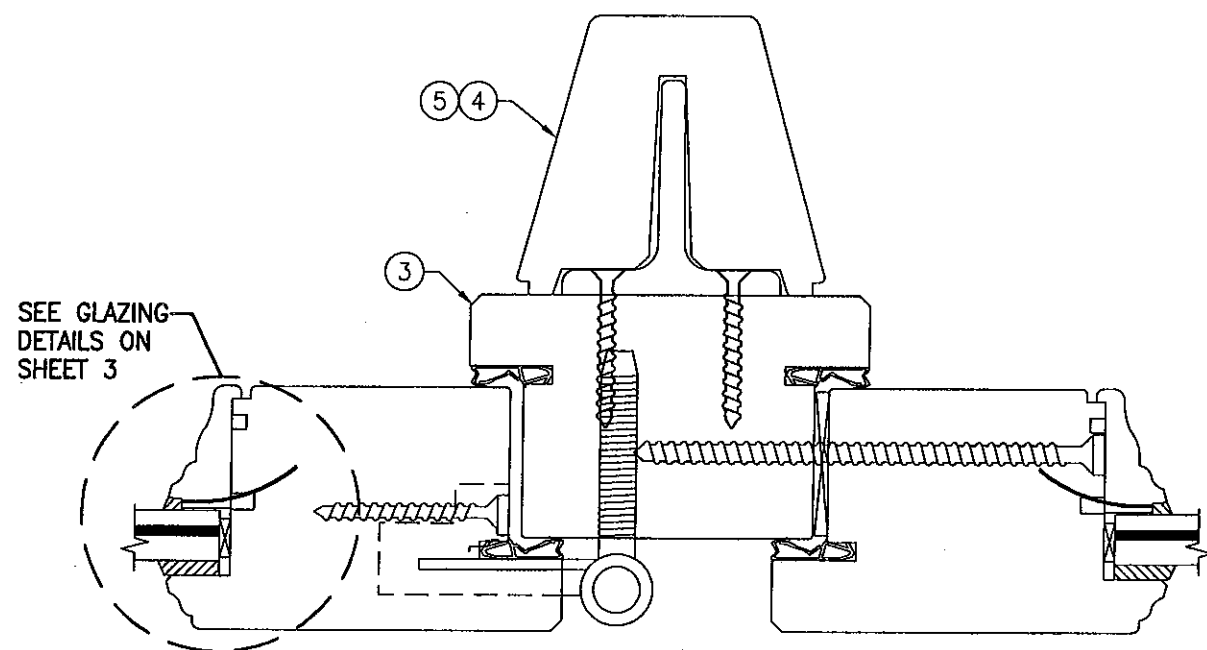


SECTION H2  
SCALE: 1/2 FULL  
(1 PIECE MULLION)  
(FOR DETAIL NOT SHOWN, SEE SECTION H1/6)

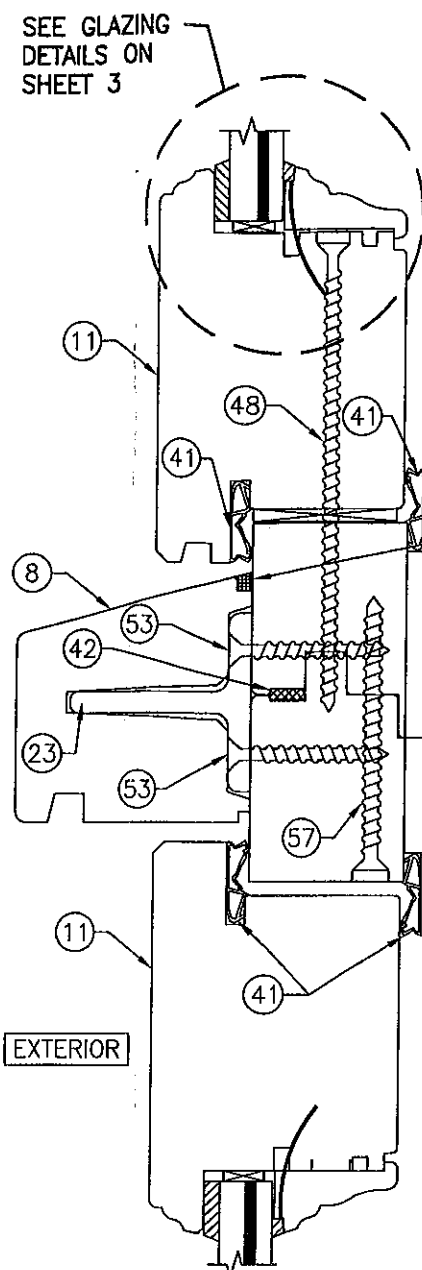

SECTION J1  
SCALE: 1/2 FULL  
(2 PIECE MULLION)

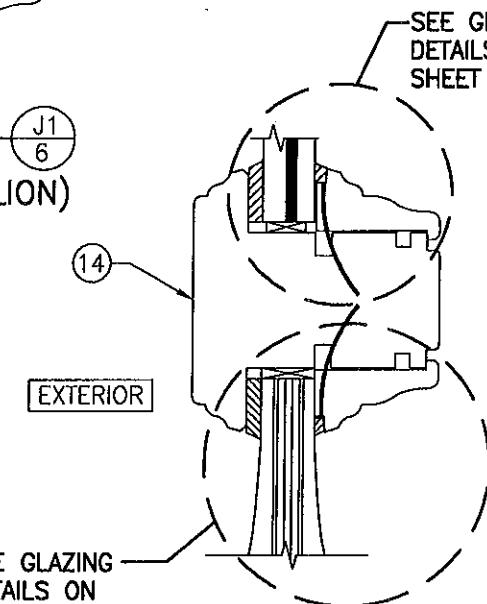

SECTION K  
SCALE: 1/2 FULL

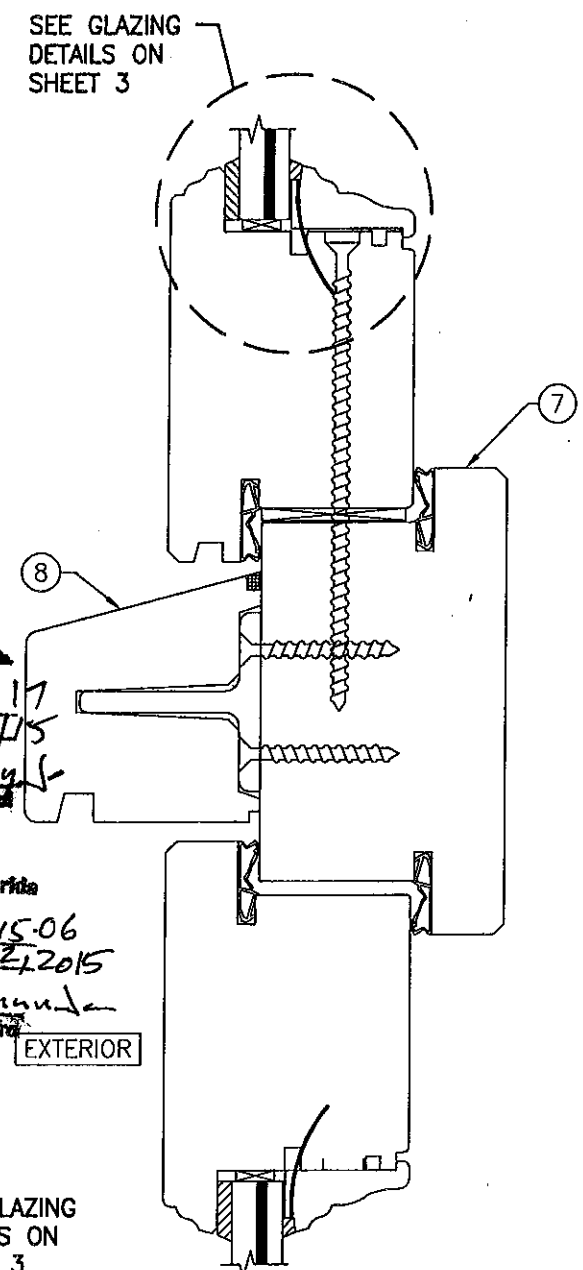


SECTION J2  
SCALE: 1/2 FULL  
(1 PIECE MULLION)  
(FOR DETAIL NOT SHOWN, SEE SECTION J1/6)

CONTINUOUS SILICONE SEALANT


PRODUCT REVISED  
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Building Code  
Acceptance No. 11-1024.17  
Expiration Date 12/22/15  
By [Signature]  
Miami Code Product Control  
Division

PRODUCT RENEWED  
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Acceptance No. 10-0615-06  
Expiration Date DEC 22, 2015  
By [Signature]  
Miami Code Product Control  
Division

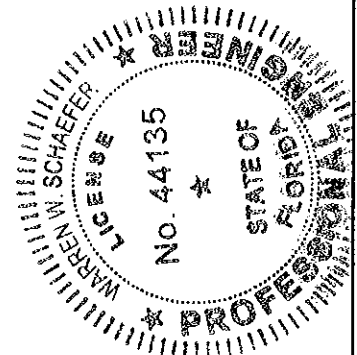


DRAWING BY: W.R.M.		CHECKED BY: W.W.S.	
PLOT: 1-24		DATE: 9/8/05	
NO.	REVISION DESCRIPTION	BY	DATE
DRAWING TITLE EUROPEAN OUTSWING IMPACT WOOD DOORS			
CONSULTANTS W. W. SCHAEFER ENGINEERING & CONSULTING, P.A. 7480 150TH COURT NORTH PALM BEACH GARDENS, FL 33418 PHONE: 561-744-3424		MANUFACTURER PETZ WINDOWS & DOORS 15951 S.W. 41ST STREET, SUITE 150 WESTON, FL 33331 954-659-3887	
CERTIFICATION JUN 09 2018		DRAWING NO. 1440	
WARREN W. SCHAEFER, P.E. P.E. NO. 44135		REV. A	
SHEET NO. 6		OF 9	



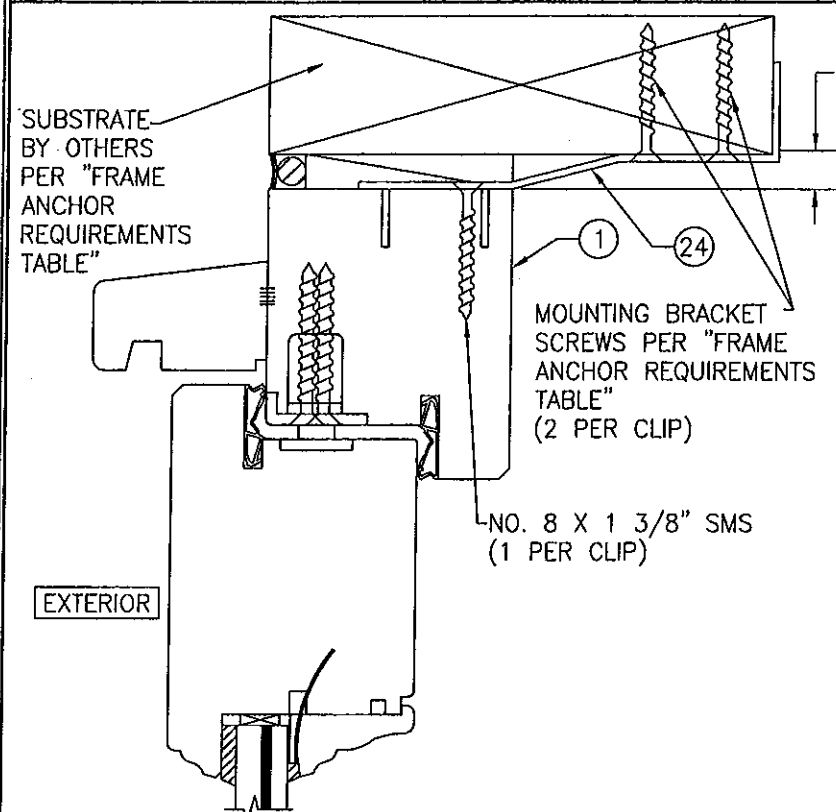


### OPTIONAL BRACKET MOUNT DETAIL AT HEAD AND SIDES

(HEAD SECTION SHOWN, SIDES ARE INSTALLED THE SAME)  
(FOR DETAIL NOT SHOWN, SEE OTHER SECTIONS)

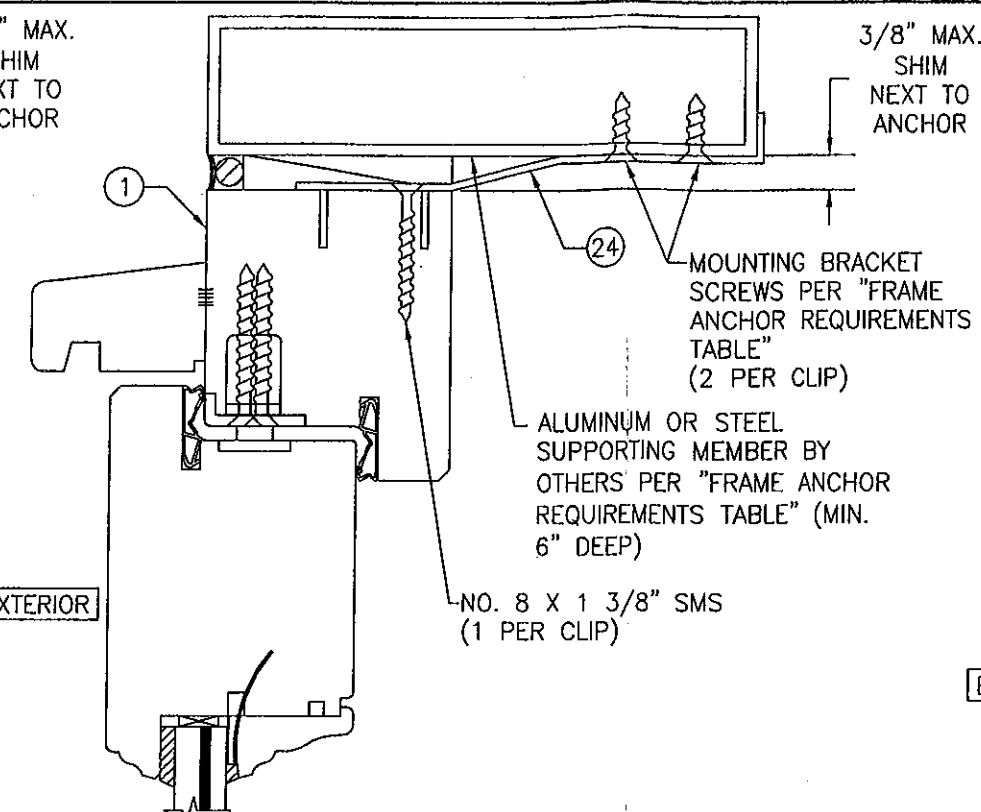


OPTIONAL BRACKET MOUNT DETAIL TO  
ALUMINUM OR STEEL

(HEAD SECTION SHOWN, SIDES ARE INSTALLED THE SAME)  
(FOR DETAIL NOT SHOWN, SEE OTHER SECTIONS)

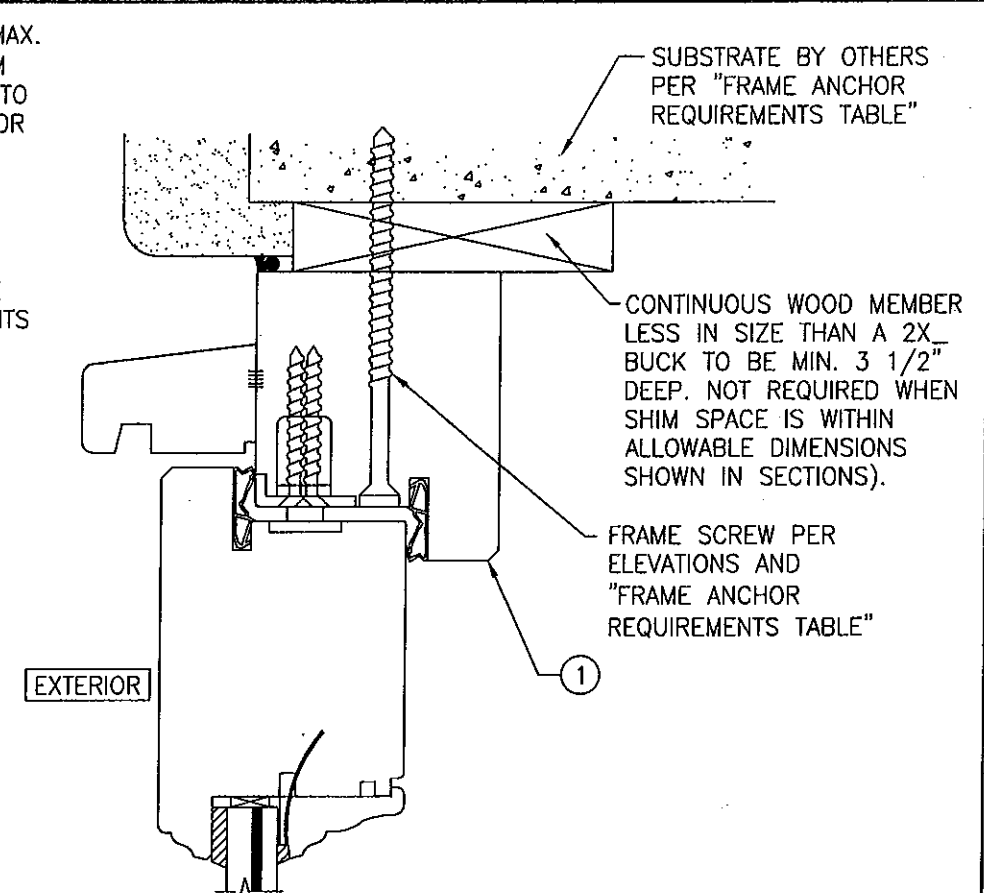


OPTIONAL DIRECT MOUNT DETAIL  
TO BLOCK OR CONCRETE WITH SPACER OR SHIM

(HEAD SECTION SHOWN, SIDES ARE INSTALLED THE SAME)  
(FOR DETAIL NOT SHOWN, SEE OTHER SECTIONS)

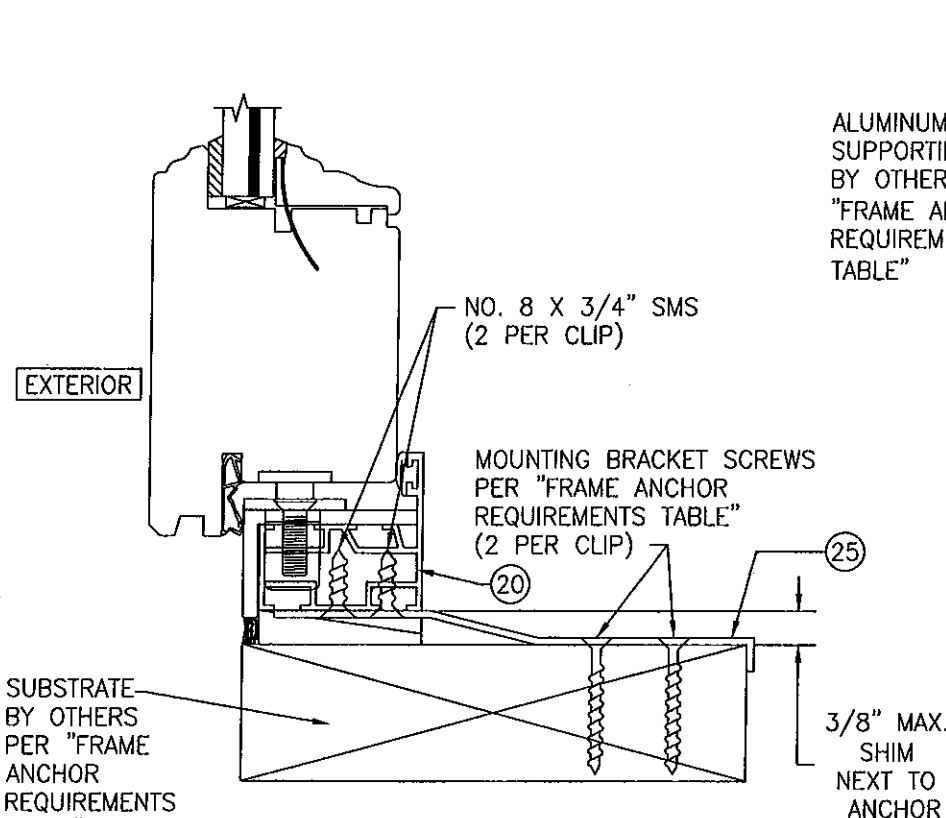

### OPTIONAL BRACKET MOUNT DETAIL AT SILL

(FOR DETAIL NOT SHOWN, SEE OTHER SECTIONS)

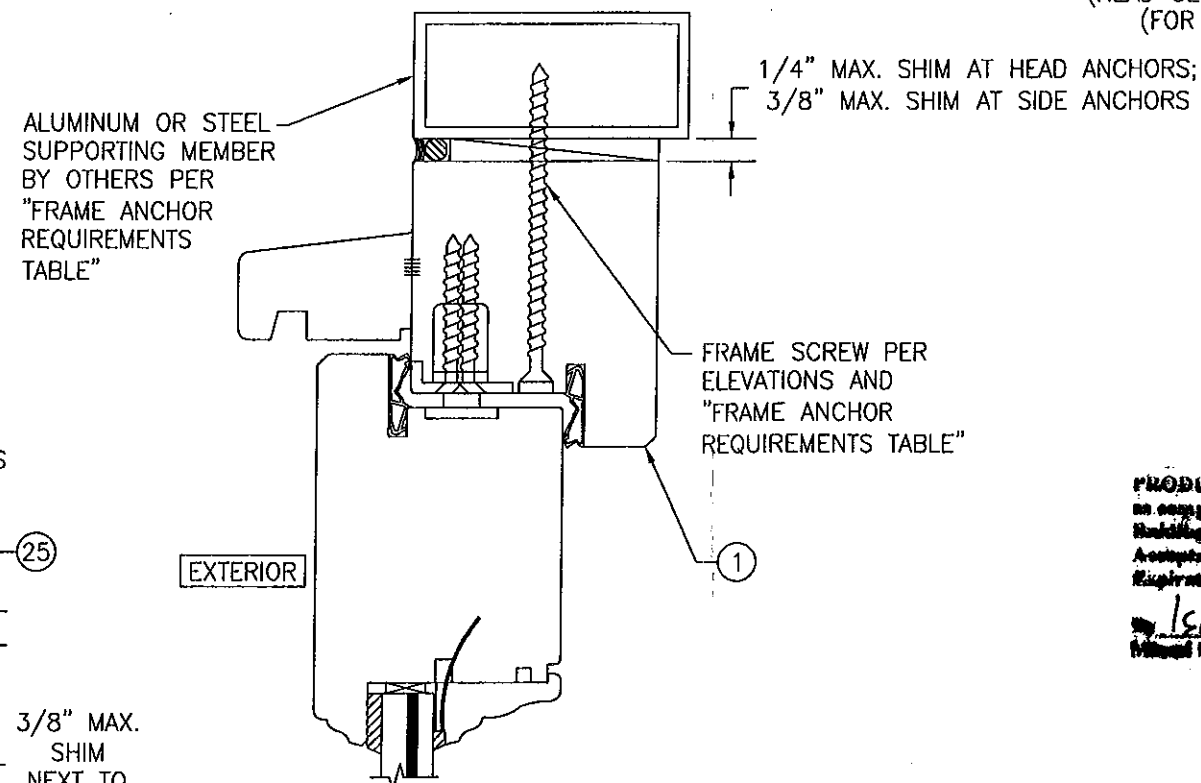























### OPTIONAL DIRECT MOUNT DETAIL TO ALUMINUM OR STEEL

(HEAD SECTION SHOWN, SIDES ARE INSTALLED THE SAME)  
(FOR DETAIL NOT SHOWN, SEE OTHER SECTIONS)

**PRODUCT RENEWED**  
as complying with the Florida  
Building Code  
Acceptance No. 10-0615-06  
Expiration Date DEC 22, 2015  
By Shane L. Chandler  
Miami-Dade Product Control  
Division

PRODUCT REVISED  
in compliance with the Florida  
Building Code  
Aspenware No. 11-1024-17  
Expiration Date 12/31/15  
by Shang J. L. L.  
Miami Trade Product Council

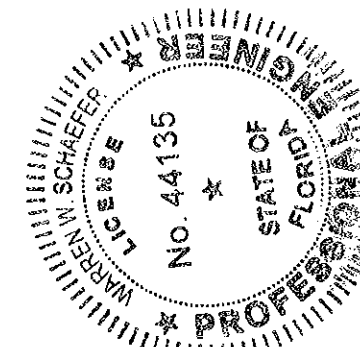[illegible]

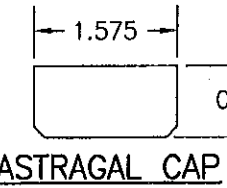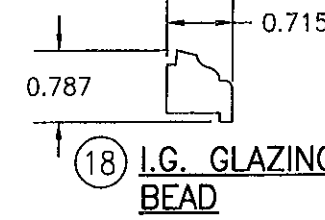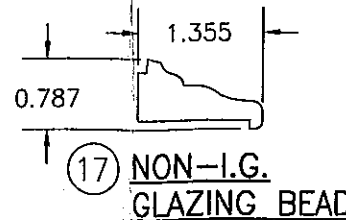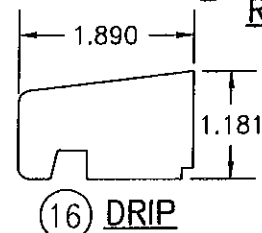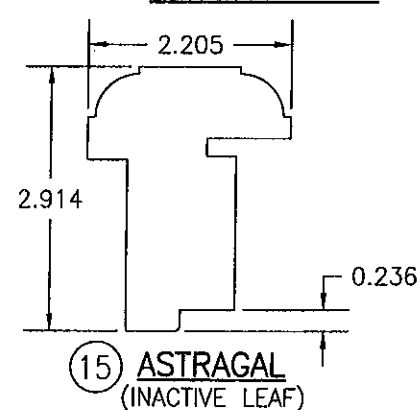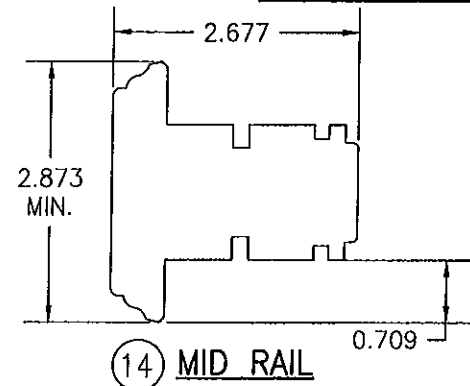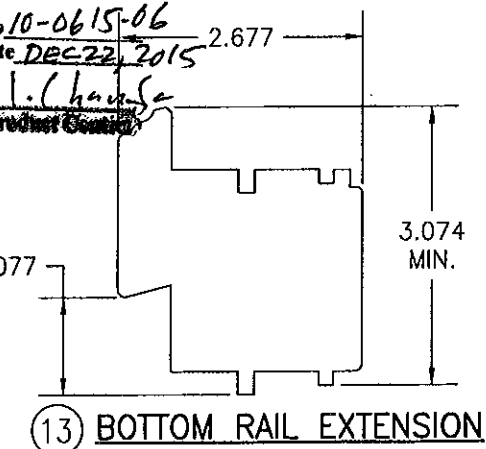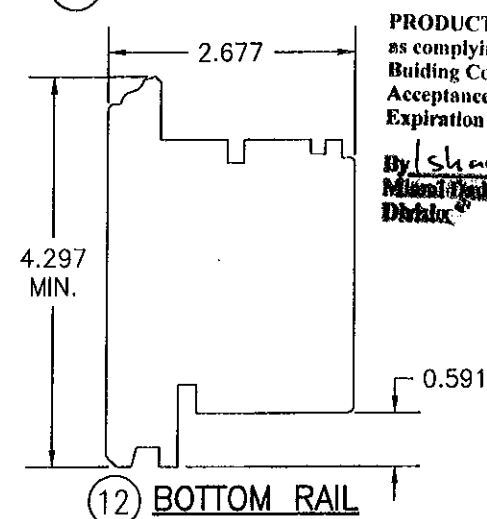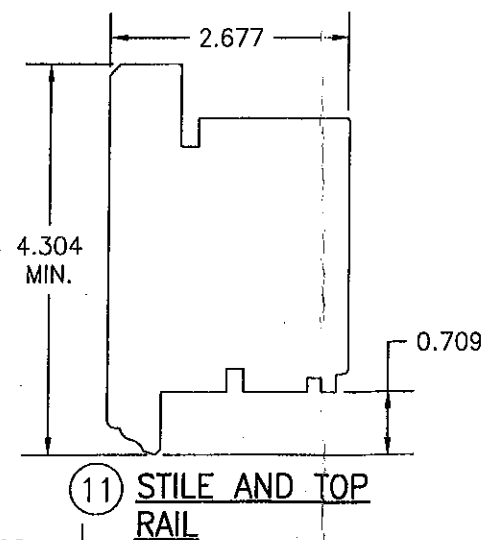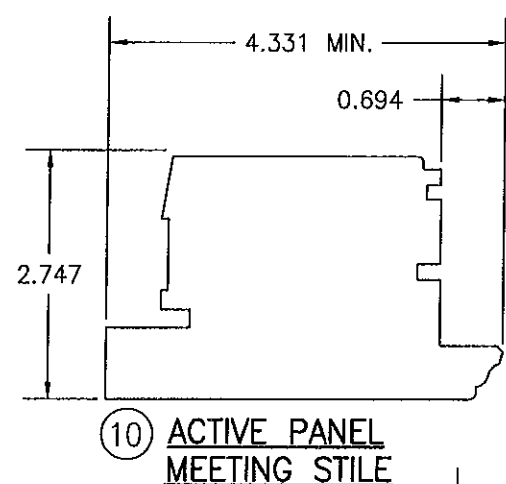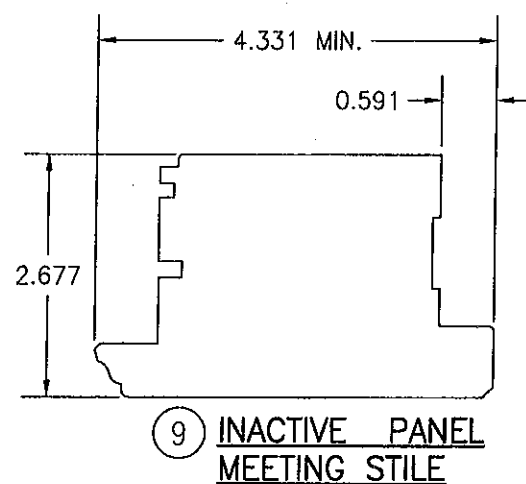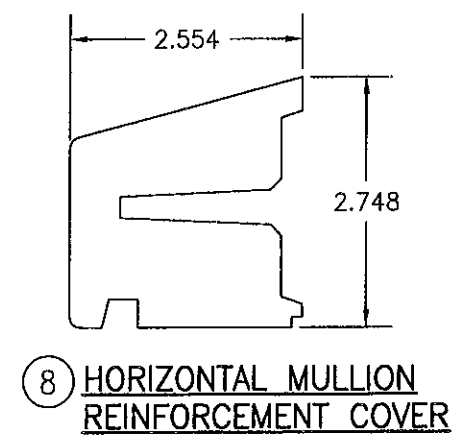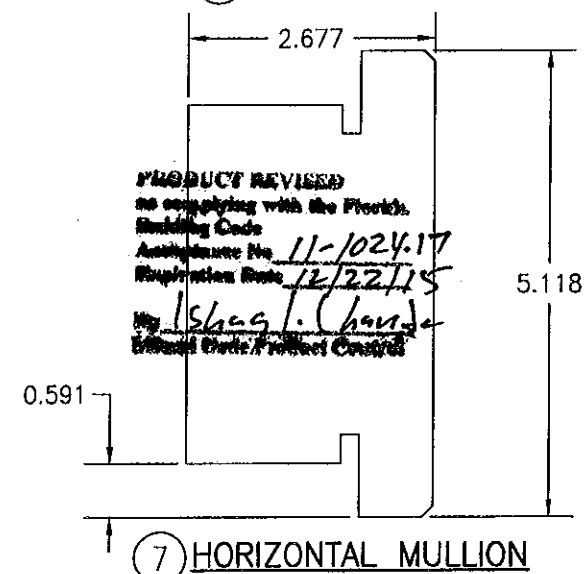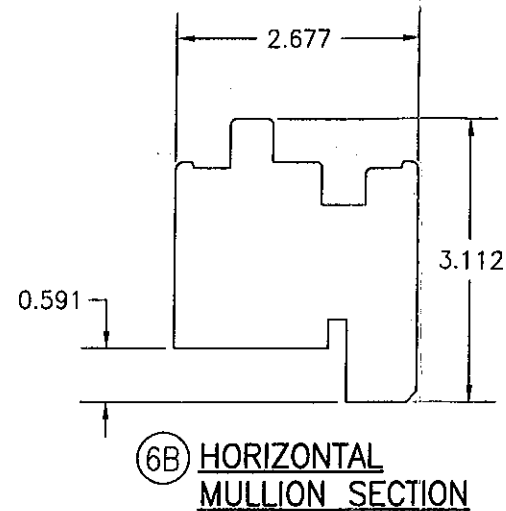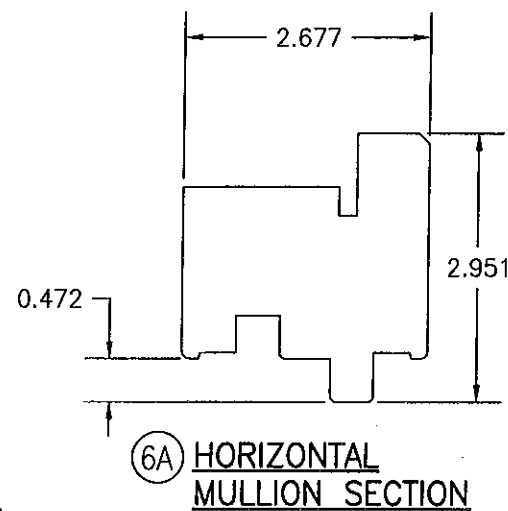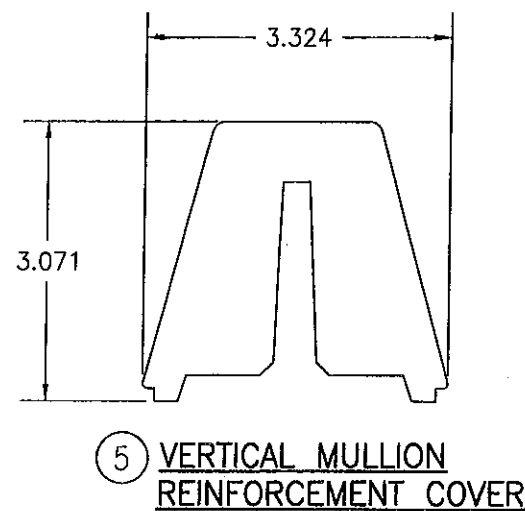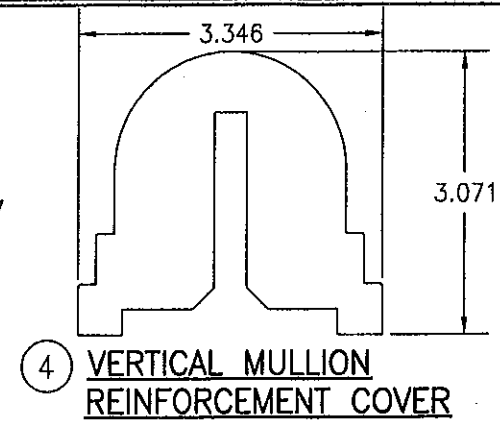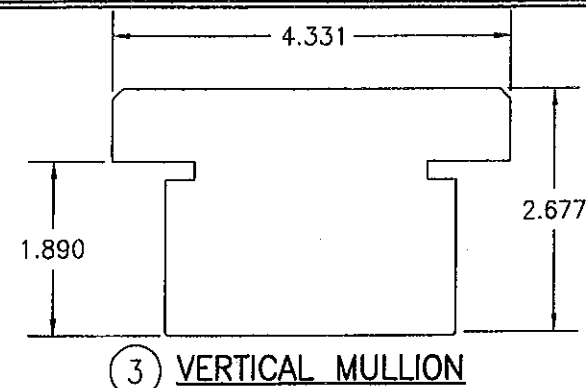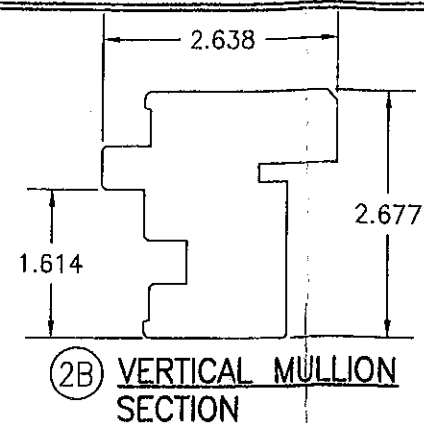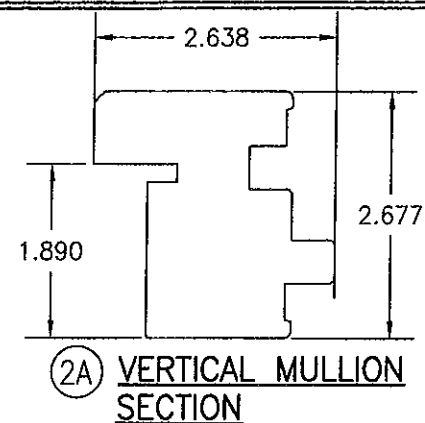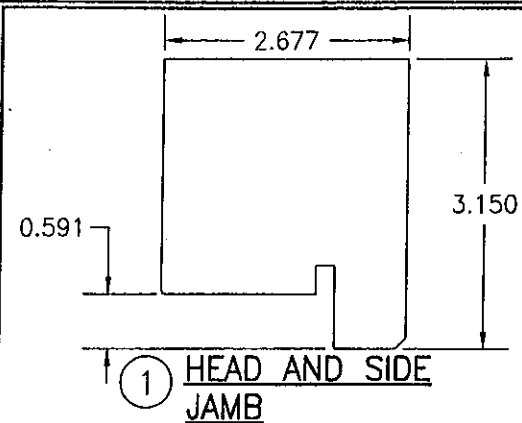


NOTE: ALL FRAME & ASTRAGAL PARTS MAY HAVE AN "OG" PROFILE AT EDGES SIMILIAR TO THE STILE & RAIL MEMBERS.

**PRODUCT REVISED**  
 as complying with the Florida  
 Building Code  
 Authorization No. 11-1024.17  
 Expiration Date 12/22/15  
 By Shag L. Chavira  
 Internal Code: Product Control

**PRODUCT RENEWED**  
as complying with the Florida  
Building Code  
Acceptance No. 10-0615-06  
Expiration Date DEC-22, 2015  
By Shang L. (hans) Lu  
Miami-Dade Product Control  
Director

A circular professional seal for Warren W. Schaefer, a Professional Engineer in the State of Florida. The seal features the text "WARREN W. SCHAEFER" on the left, "LICENSE NO. 44135" in the center, and "STATE OF FLORIDA" on the right. The words "PROFESSIONAL ENGINEER" are written around the top inner edge of the seal. The seal is surrounded by a decorative border of small vertical lines.

CERTIFICATION  JUN 09 2010 WARREN W. SCHAEFER, P.E. P.E. NO. 44135	DRAWING NO.		REV.
	1440		A
	SHEET NO.		
	8	OF	9
	DRAWING TITLE		
	EUROPEAN OUTSWING IMPACT WOOD DOORS  CONSULTANTS W. W. SCHAEFER ENGINEERING & CONSULTING, P.A. 7480 150TH COURT NORTH PALM BEACH GARDENS, FL 33418 PHONE: 561-744-3424		
MANUFACTURER		PEETZ WINDOWS & DOORS 15951 S.W. 41ST STREET; SUITE 150 WESTON, FL 33331 954-659-3887	
NO.	REVISION DESCRIPTION	BY	DATE
DRAWN BY: W.R.M.		CHECKED BY: W.W.S.	
PLOT: 1=24		DATE: 9/8/05	

